

PLANNING OR DESIGN


DATE: 03-17-14 ISSUE:

**REVISION:** 

<u>A</u> REV. 03-31-14

SHEET TITLE:

GRADING PLAN

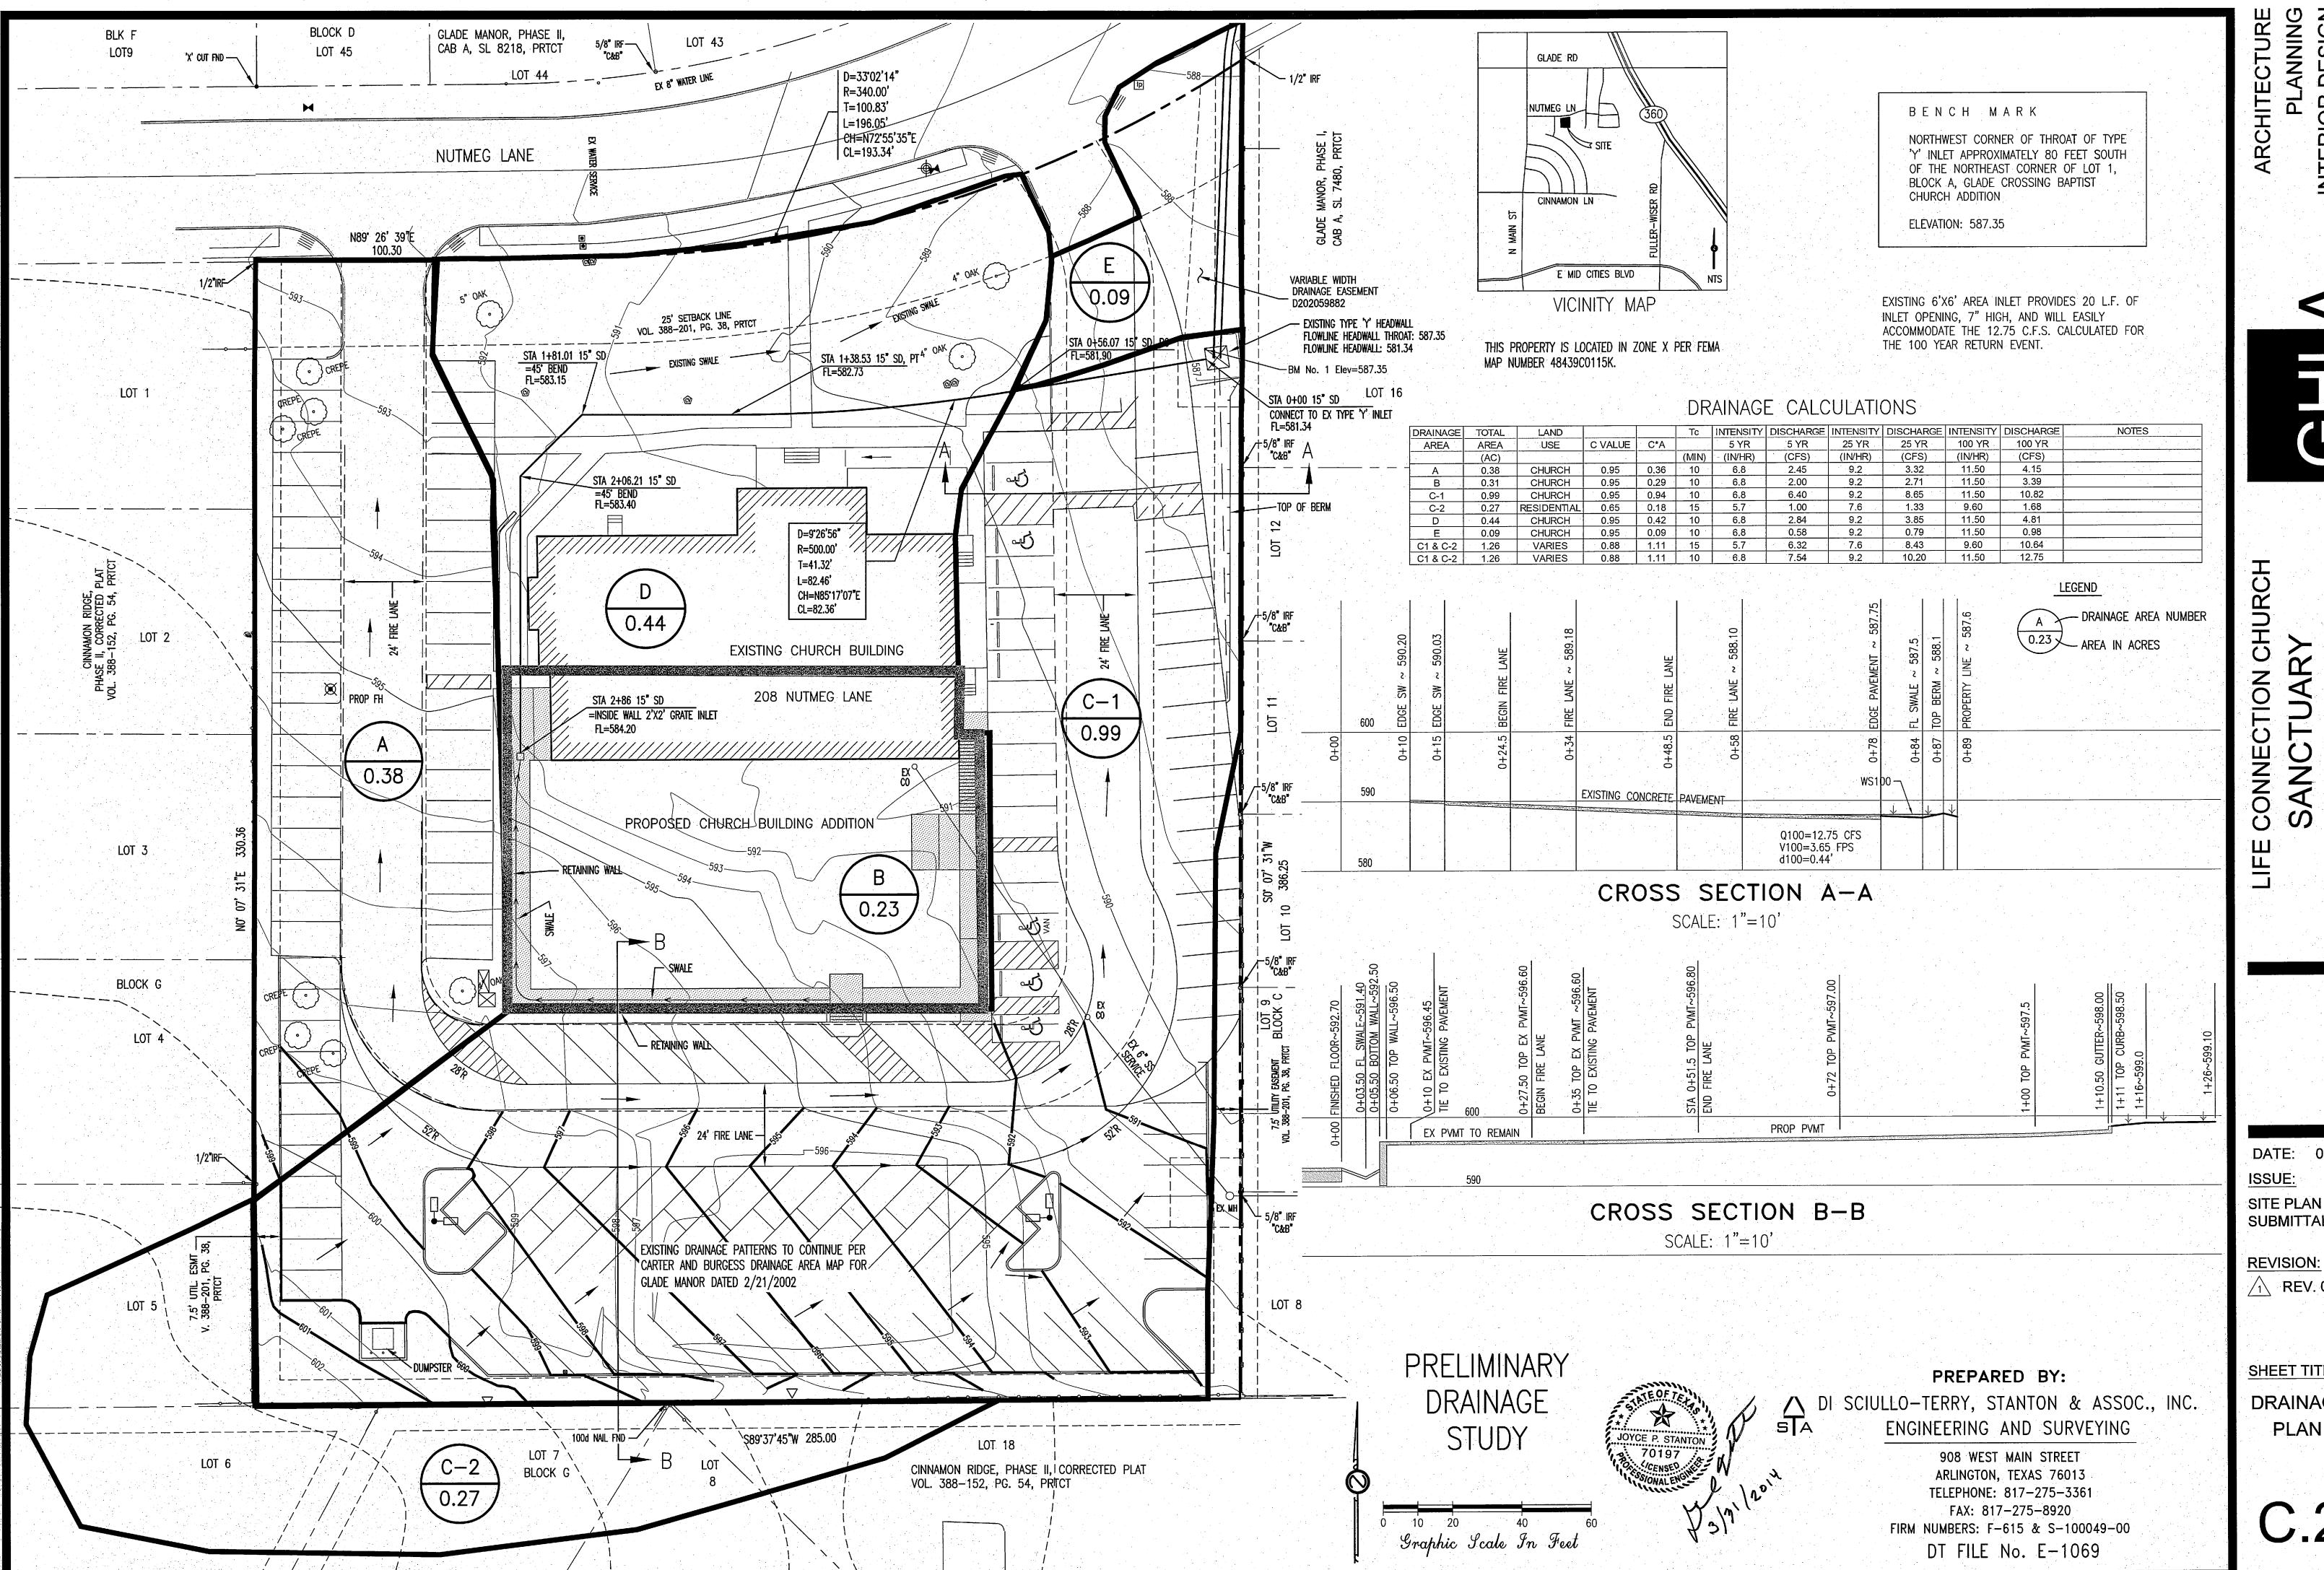

ANNING DESIGN INTERIOR


DATE: 03-17-14

SITE PLAN SUBMITTAL

↑ REV. 03-31-14

SHEET TITLE:

DRAINAGE PLAN

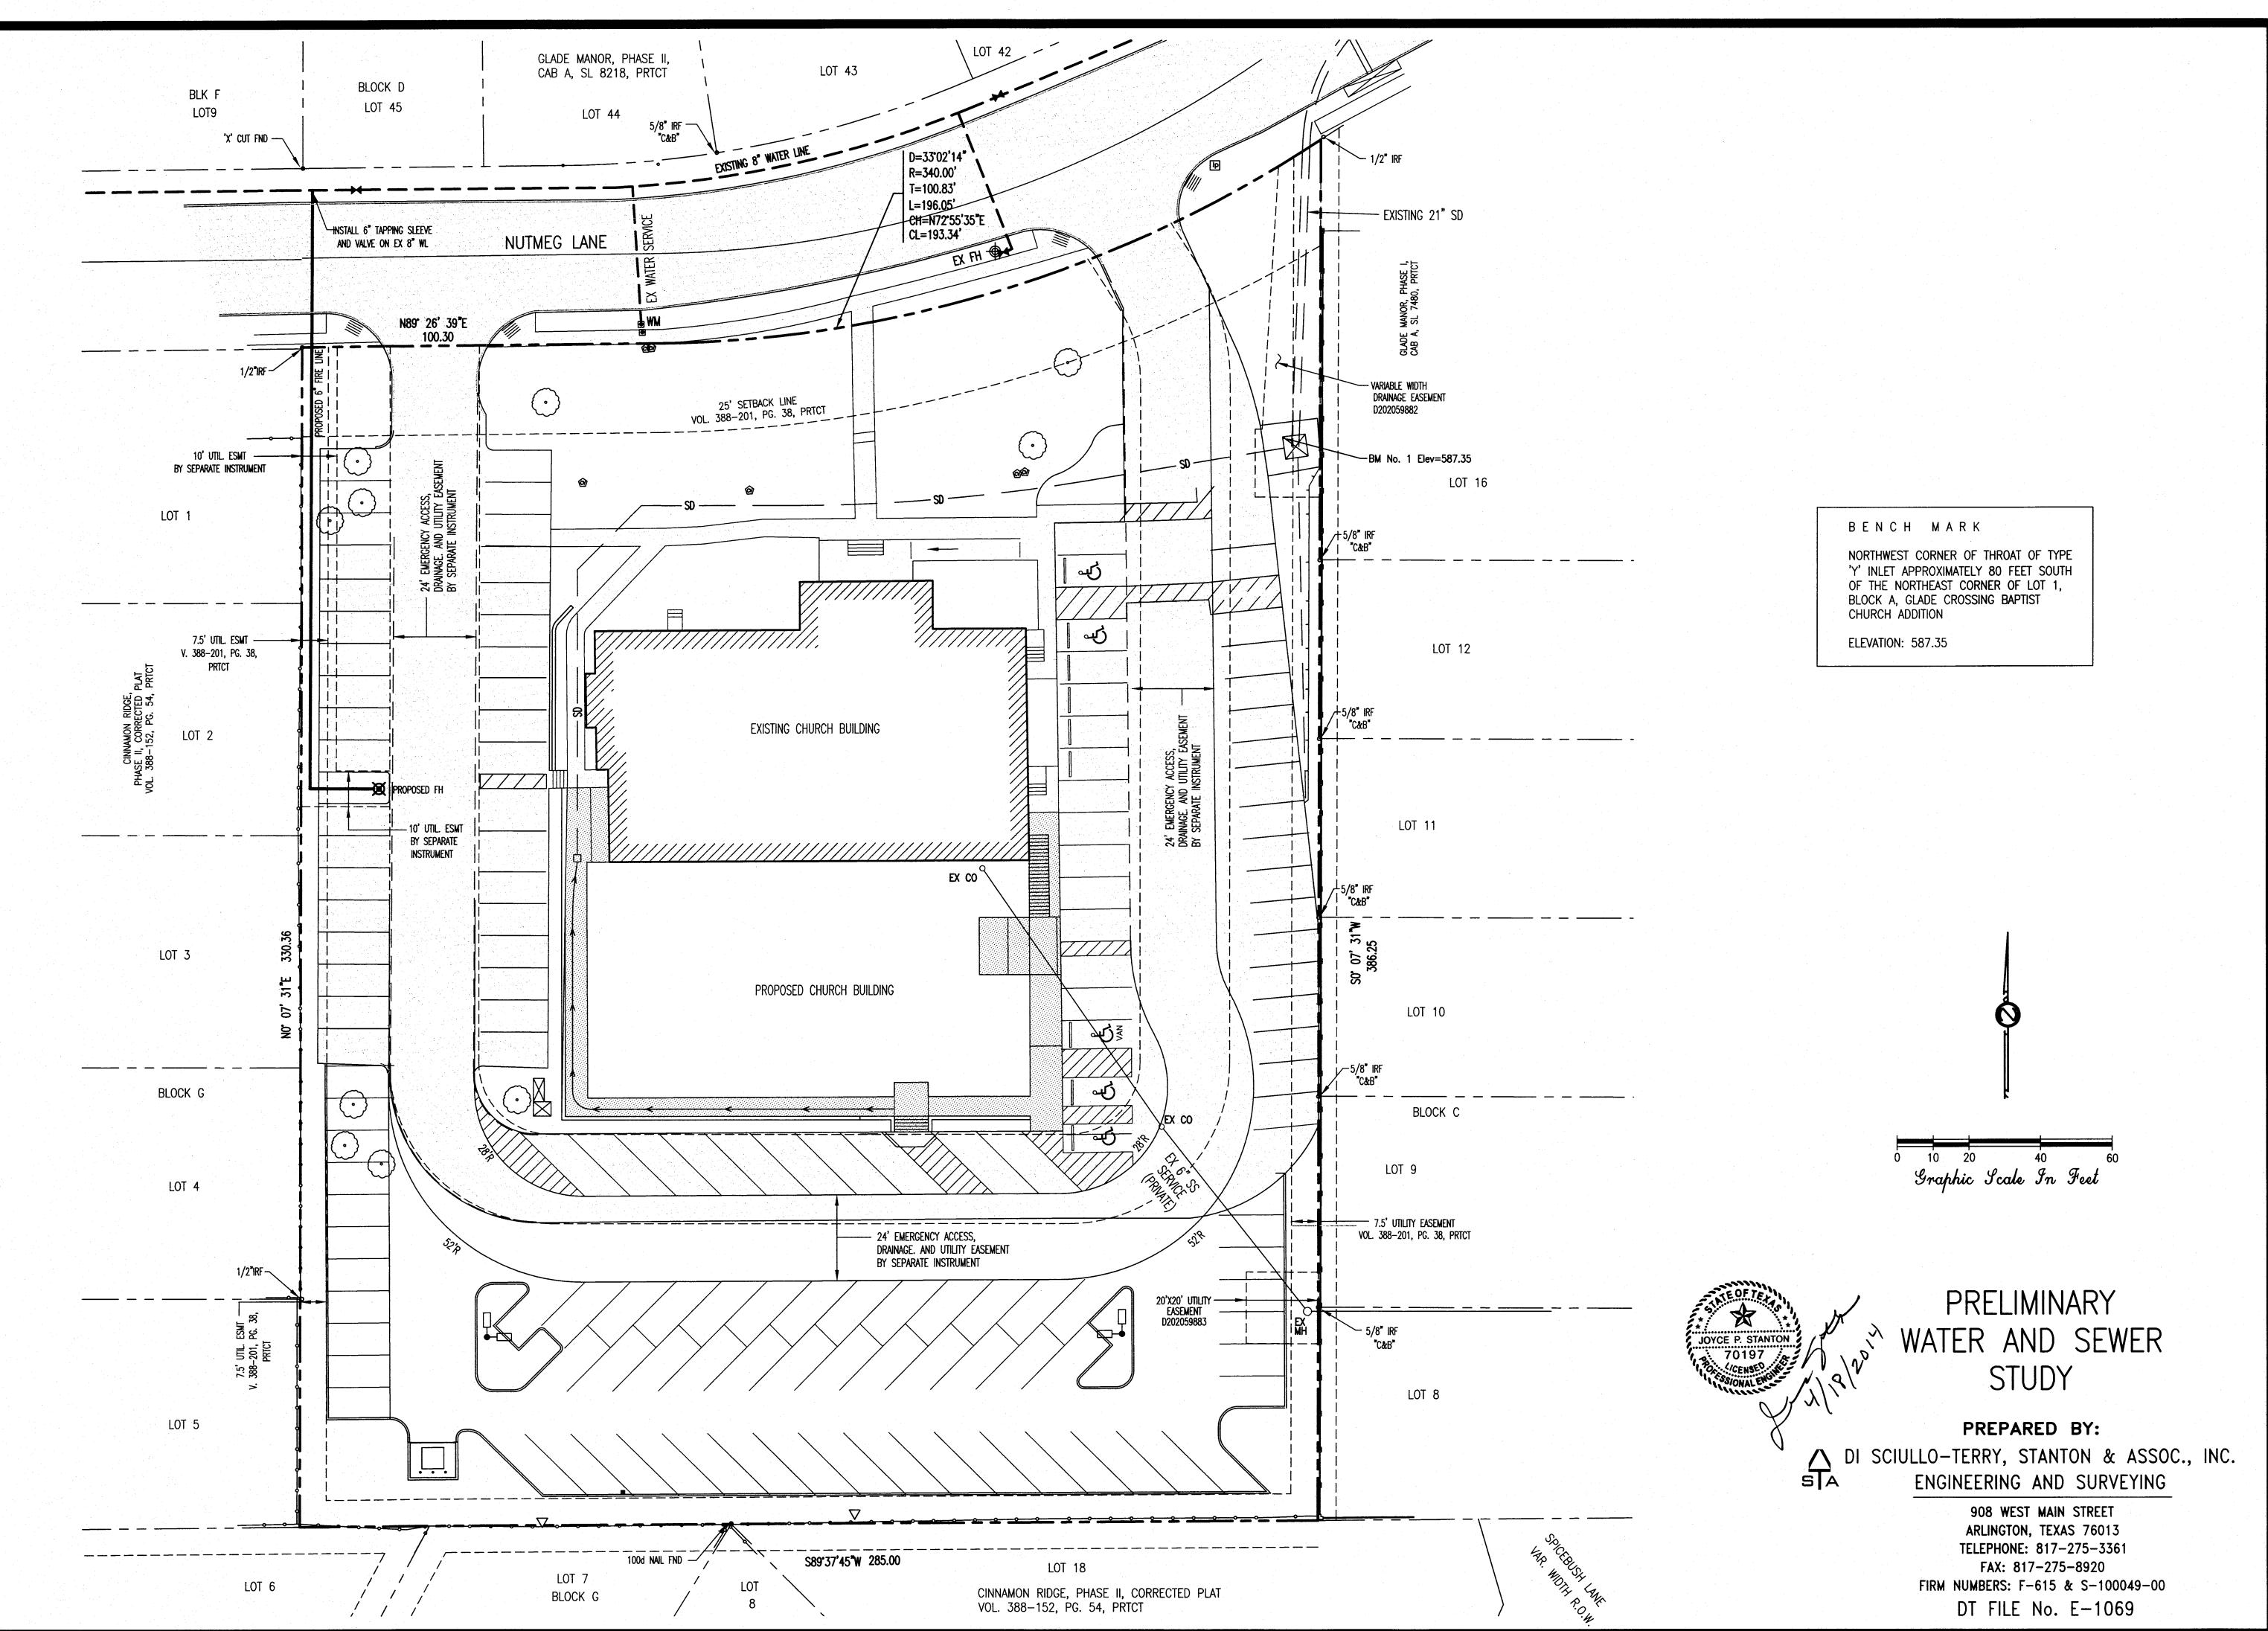

ANNING DESIGN **ARCHITECTURE** INTERIOR



CONNECTION CHURCH

DATE: 03-17-14 ISSUE:

SITE PLAN SUBMITTAL

**REVISION:** 

<u>1</u> REV. 03-31-14

SHEET TITLE: WATER AND SANITARY SEWER

PLAN

IRRIGATOR AND SHALL BE SUBMITTED WITH THE BUILDING PERMIT APPLICATION.

### LANDSCAPE NOTES

CONTRACTOR SHALL STAKE ALL TREE LOCATIONS AND BED CONFIGURATIONS FOR APPROVAL BY LANDSCAPE ARCHITECT PRIOR TO INSTALLATION. ALLOW A MINIMUM OF 48 HOURS NOTICE TO THE LANDSCAPE ARCHITECT.

CONTRACTOR SHALL VERIFY LOCATION OF ALL UNDERGROUND UTILITIES PRIOR TO CONSTRUCTION. ANY DAMAGE TO EXISTING UTILITIES CAUSED BY CONTRACTOR OR SUBCONTRACTOR SHALL BE THE RESPONSIBILITY OF THE CONTRACTOR AND SHALL BE REPAIRED IN A TIMELY MANNER AT NO ADDITIONAL COST TO THE OWNER.

CONTRACTOR SHALL ADVISE THE OWNER OF ANY CONDITION FOUND ON-SITE OR OFF-SITE WHICH PROHIBITS INSTALLATION AS

ALL SHRUB AND GROUNDCOVER BEDS SHALL HAVE A MINIMUM OF FOUR INCHES (4") HARDWOOD BARK MULCH. SEE

TREES SHALL BE LOCATED A MINIMUM OF FIVE FEET (5') FROM ALL UTILITY LINES, AND SIDEWALK. TREES SHALL NOT BE LOCATED IN UTILITY EASEMENTS. TREES SHALL BE LOCATED A MINIMUM OF THREE FEET (3') FROM ALL FIRE HYDRANTS.

CONTRACTOR SHALL MAINTAIN LANDSCAPE AREAS IN A NEAT AND ORDERLY MANNER UNTIL FINAL ACCEPTANCE BY THE OWNER. MAINTENANCE SHALL CONSIST OF WEEDING, WATERING, MOWING AND EDGING, SPRAYING, FERTILIZING, GARBAGE AND DEBRIS REMOVAL, TEMPORARY EROSION CONTROL AND EROSION REPAIR AT A MINIMUM.

MINIMUM ONE PUNCH LIST WALK THROUGH SHALL BE REQUIRED PRIOR TO FINAL ACCEPTANCE. CONTACT LANDSCAPE ARCHITECT MINIMUM 1 WEEK PRIOR TO SITE VISIT.

CONTRACTOR SHALL REPLACE WITHIN TWO WEEKS OF WRITTEN NOTICE BY THE OWNER ANY PLANT MATERIAL WHICH IS CONSIDERED TO BE DAMAGED, DESTROYED, REMOVED OR DEAD. CONTRACTOR SHALL REPLACE PLANT MATERIAL WITH SIMILAR

SITE SHALL BE IRRIGATED WITH AN AUTOMATIC IN-GROUND IRRIGATION SYSTEM. CONTRACTOR SHALL ENSURE NO OVERSPRAY ON STREETS AND WALKWAYS. CONTRACTOR SHALL OBTAIN A PERMIT FROM THE CITY FOR THE IRRIGATION SYSTEM. PERMIT AND IMPACT FEES SHALL BE PAID BY THE CONTRACTOR TO THE CITY FOR THE IRRIGATION METER PRIOR TO A PERMIT RELEASE. PLANTS SHALL CONFORM WITH THE STATE OF TEXAS REGULATIONS FOR NURSERY INSPECTIONS, RULES AND RATINGS.

all plants shall be free of disease and insect infestation with a normal growth habit. All trunks shall be FREE OF EXCESSIVE ABRASIONS OR FRESH ABRASIONS.

CONTRACTOR SHALL GUARANTEE PLANTS FOR A PERIOD OF ONE YEAR AFTER INSPECTION AND ACCEPTANCE. CONTRACTOR SHALL PROVIDE ONE YEAR MAINTENANCE ON PLANT MATERIALS.

CONTRACTOR SHALL PROVIDE COPIES OF ORIGINAL INVOICES SHOWING PLANT SIZES AND SPECIES DELIVERED TO SITE (PRICE MAY BE DELETED), UPON DELIVERY OF PLANT MATERIALS. PLANT MATERIALS WHICH DO NOT MEET PLANT LIST SIZE, SPECIES AND GROWTH HABIT SHALL BE REJECTED. REJECTED PLANTS SHALL BE IMMEDIATELY REMOVED FROM SITE BY THE CONTRACTOR, UNLESS PRIOR WRITTEN AUTHORIZATION HAS BEEN RECEIVED.

PLANT QUANTITIES ARE PROVIDED FOR CONTRACTOR CONVENIENCE. CONTRACTOR SHALL VERIFY PLANT QUANTITY PRIOR TO

CONTRACTOR SHALL NOTIFY OWNER/LANDSCAPE ARCHITECT 48 HOURS PRIOR TO SCHEDULED START OF PLANT INSTALLATION. STEEL EDGING SHALL BE PLACED BETWEEN TURF AND GROUNDCOVER OR SHRUB BEDS AS INDICATED ON THE DRAWINGS. INSTALL STEEL EDGING PER MANUFACTURER'S RECOMMENDATIONS.

SALVAGED ROCKS SHALL BE PLACED ON MIRAFI NON-WOVEN GEOTEXTILE FABRIC ON COMPACTED SUBGRADE. MODIFY IRRIGATION IN THE AREA TO REMOVE FROM AREA. DEPTH OF ROCK SHALL BE A MINIMUM OF 4". GEOTEXTILE FABRIC SHALL NOT BE VISIBLE THROUGH ROCK. BOULDERS SHALL BE IMBEDDED A MINIMUM OF 1/4 OF THE HEIGHT OF THE BOULDER. STAKE BOULDER LOCATIONS IN THE FIELD FOR REVIEW BY LANDSCAPE ARCHITECT PRIOR TO INSTALLATION. ALLOW MINIMUM 48 HOURS FOR REVIEW PRIOR TO SCHEDULED INSTALLATION.

SEE SITE AND CIVIL PLANS FOR LAYOUT, UTILITIES AND GRADING.

#### **IRRIGATION NOTES:**

PRIOR TO BEGINNING WORK, VERIFY EXISTING IRRIGATION SYSTEM IS WORKING. NOTE ANY AREAS IN THE LIMITS OF CONSTRUCTION WHICH ARE NOT WORKING CORRECTLY AND REFER THEM TO THE OWNER PRIOR TO DOING ANY IRRIGATION WORK. PRIOR TO BEGINNING WORK, VERIFY INSTALLATION OF CITY AND STATE REQUIRED BACKFLOW PERVENTOR, Y-FILTER AND BALL VALVE. IF MAINLINE IS TO BE MODIFIED, POINT OF CONNECTION SHALL MEET CURRENT TCEQ STANDARDS. INSTALL AS

WITHIN THE LIMITS OF CONSTRUCTION, MODIFY EXISTING IRRIGATION AS REQUIRED TO PROVIDE 100% COVERAGE WITHIN THE AREA. TURF AREAS SHALL BE IRRIGATED SEPARATELY FROM SHRUB AREAS.

FOR THE PROPOSED TREES, PROVIDE DRIP IRRIGATION IF NO TURF IRRIGATION EXISTS WHERE TREES ARE TO BE INSTALLED. VERIFY THAT EXISTING CONTROLLER HAS ADDITIONAL SECTIONS, OR RECOMMEND A NEW CONTROLLER IF CURRENT CONTROLLER

WILL NOT HANDLE NEW SECTIONS (IF REQUIRED). VERIFY RAIN AND FREEZE PROTECTION ARE IN PLACE ON CONTROLLER AND WORKING, IF NOT, ADD NEW RAIN AND FREEZE

PER TCEQ REQUIREMENTS, LANDSCAPE AREAS WHICH ARE LESS THAN 4' WIDE SHALL HAVE DRIP IRRIGATION INSTALLED. INSTALL

A MINIMUM OF ONE IRRIGATION WALK THROUGH SHALL BE REQUIRED AT THE END OF THE JOB TO OBSERVE THE IRRIGATION CHANGES. CONTACT LANDSCAPE ARCHITECT A MINIMUM OF 5 DAYS PRIOR TO SITE VISIT TO SCHEDULE.

### **GROUNDCOVER AREAS A-D**

EXISTING IRRIGATION WITHIN BED SHALL NOT BE DAMAGED. LOCATE PRIOR TO INSTALLING PLANTS. ENSURE DRIP TUBE IS BURIED MINIMUM 2" BELOW GRADE AFTER INSTALLATION AND IS NOT VISIBLE THROUGH MULCH.

REMULCH ENTIRE PLANTING BED AFTER PLANT INSTALLATION.

GC AREA A ±50SF: ADD 3-5 LM AS REQUIRED TO FILL REMAINING SPACE AT SIDEWALKS EAST OF BOULDER. ADD 1 GIANT LIRIOPE NORTH OF WEST END OF BOULDER, BETWEEN BOULDER AND PR.

GC AREA B ±75SF: ADD 5-6 GIANT LIRIOPE BETWEEN EXISTING 2 GIANT LIRIOPE. NORTH OF EXISTING GSN AND EXISTING GIANT LIRIOPE, REMOVE 2 L. INSTALL 15 LPP 2 GAL. AT 18" OC. SOUTH OF EXISTING 2 GIANT

GC AREA C ±150SF: REMOVE ALL PLANTS NORTH OF SIGN. EXISTING GIANT LIROPE WEST OF SIGN SHALL REMAIN. INSTALL 1 KOR AS SHOWN. INSTALL MINIMUM 65 AJ, 1 GALLON AT 12" O.C. IN FRONT OF SIGN AND KOR. BED SHALL APPEAR FULL AT INSTALLATION. ALSO INSTALL AT SOUTHEAST CORNER OF BED 21-25 GOLDEN DAWN NARCISSUS OR SIR WINSTON CHURCHILL NARCISSUS AT 6" OC. IN ASIAN JASMINE. NARCISSUS SHALL BE INSTALLED 6" BELOW FINISH GRADE. IF PLANTS ARE UNAVAILABLE DUE TO TIME OF YEAR INSTALLED, CONTACT LANDSCAPE ARCHITECT PRIOR TO INSTALLING ANY PLANT MATERIAL.

GC AREA D ±35SF: REMOVE 3-5 EXISTING LIRIOPE. INSTALL 35-40 AJ, 1 GAL. AT 12" O.C. TO FILL 35 SF OF

#### **EXISTING PLANT SYBMOLS:**

BOULDER SHRUB: CLEYERA SMALL TREE: CREPE MYRTLE

SMALL TREE: CREPE MYRTLE SHRUB: DWARF YAUPON HOLLY GROUNDCOVER (GENERIC DESCRIPTION) GROUNDCOVER: GIANT LIRIOPE

SHRUB: INDIAN HAWTHORNE GROUNDCOVER/ORNAMENTAL GRASS: MEXICAN FEATHERGRASS

LARGE TREE: LIVE OAK SHRUB: NANDINA 'NANA' SHRUB: ROSEMARY

THE LANDSCAPE ARCHITECT.

SYM	QTY	COMMON NAME	LATIN NAME		SIZE	COMME	INTS						
TREES													
LO	1	LIVE OAK	QUERCUS VIRGINIA	NA	3"	SINGLE	STRAIGH1	TRU	NK, MIN.	12' HT.	, 6' SPF	RD. AT	INSTALLATIO
LE	3	LACEBARK ELM	ULMUS PARVIFOLIA	ILMUS PARVIFOLIA			STRAIGH1	TRU	NK, MIN.	12' HT.	, 6' SPF	RD. AT	INSTALLATIO
SHRUB	S												
BH	45	BURFORD HOLLY	ILEX CORNUTA	'BURFORDII'			5 GA	L.	MIN. 36	' HEIGHT	at instal	LATION,	PLANT 4' 0
KOR	1	KNOCK OUT ROSE 'RED'	ROSA X 'KNOC	K OUT' (RED)			5 GA	L.	MIN. 24	' HEIGHT	at instal	LATION,	PLANT 3' 0
LPH	68	HINES PURPLELEAF FRINGE FLOW	ER LORAPETALUM CHI	LORAPETALUM CHINENSE VAR RUBRUM 'HINES PURPLE LE			5 GA	L.	MIN. 36	' HEIGHT	at instal	LATION,	PLANT 4' C
RMP	2	MARIE PAVIE ROSE	ROSA X 'MARIE	ROSA X 'MARIE PAVIE'			5 GAL.		MIN. 24	' HEIGHT	at instal	LATION,	PLANT 3' C
GROUNE	COVER	AND TURF											
AJ	105	ASIAN JASMINE	TRACHELOSPER	MUM ASIATICUM			1 GAL.	FULL	. IN POT,	INSTALL	12" ON C	CENTER	
GL	13	GIANT LIRIOPE	LIRIOPE ?				1 GAL.	FULL	. IN POT,	INSTALL	12" ON C	ENTER	
LM	7	BIG BLUE LIRIOPE	LIRIOPE MUSCA	RI 'BIG BLUE'			1 GAL.	FULL	. IN POT,	INSTALL	12" ON C	CENTER	
LPP	23	PURPLE PIXIE FRINGE FLOWER	LORAPETALUM CHI	NENSE VAR RUBRUM	'PURPLE PIX	(IE'	2 GAL.	FULL	. IN POT,	INSTALL	18" ON C	CENTER	
NAR	25	NARCISSUS 'GOLDEN DAWN	NARCISSUS 'GC	LDEN DAWN'			BULB	INST	ALL 6" 0	N CENTER	<b>\</b>		
TURF		SEE GRASS ESTABLISHMENT	NOTES	·	·								

LANDSCAPE ARCHITECT

P.O. BOX 17387 / FORT WORTH, TEXAS 76102 2328 PRIMROSE AVENUE / FORT WORTH, TEXAS 76111 ALIS@AKMLA.COM / 817.875.1839

> THE TEXAS BOARD OF ARCHITECTURAL EXAMINERS 8213 SHOAL CREEK BOULEVARD, SUITE 107 AUSTIN, TEXAS 78758 TELEPHONE: 512.458.4126 HAS JURISDICTION OVER THE INDIVIDUAL LICENSED UNDER THI LANDSCAPE ARCHITECTS REGISTRATION LAW, ARTICLE 249C,

LANDSCAPE DATA							
TOTAL SITE AREA: ±2.24 ACRES (±97,539 SF) ZONED: R-							
PARKING SPACES PROVIDED: 143							
	REQUIRE	:D	PROVIDED				
STREET YARD LANDSCAPE (25,831SF) (84–334(a).	15% 3,875 SI	F	56% 14,500 SF				
STREET YARD TREES (1 LG. TREE/2,000SF OVER 10,000SF + 10 TREES) (84–334(b).	18*		18*				
STREET YARD SHRUBS (1 SHRUB/100SF STYD REQ.D OVER 1,500SF + 30) (84-334(c).	44*		59*				
STREET YARD GROUNDCOVER (150SF + 5% OF REQ.D LANDSCAPE AREA OVER 1,500SF (84-334(d).	219 SF*	k	310 SF*				
PARKING LOT ISLAND – STREETYARD (90SF TREE PER 12 P. SPACES) 21 SPACES (84-334(e)(1)	157.5 SI	F	0 SF				
PARKING LOT ISLAND — NONSTREETYARD (60SF TREE PER 12 P. SPACES) 122 SPACES (84–334(e)(2)	610 SF		1,410 SF				
SCREEN REQUIREMENTS (84-336)	WEST	SOUTH		EAST			
5' SETBACK PROVIDED LIVING SCREEN PROVIDED MASONRY FENCE PROVIDED (EXISTING) WOOD FENCE PROVIDED (EXISTING)	YES NO NO YES		res No No res	N0** N0** YES N0			

VERNON'S TEXAS CIVIL STATUTES.

84-334 AND 84-336 REFERS TO THE ZONING REGULATIONS OF THE CITY OF EULESS. LARGE TREES SHALL BE A MINIMUM OF 3" CALIPER, AND 12' HEIGHT AT TIME OF PLANTING (84-334(b).

IN LIEU OF 1 LARGE TREE, 2 SMALL TREES MAY BE USED. NOT MORE THAN 50% OF THE REQUIRED LARGE TREES MAY BE SUBSTITUTED (84-334(b)(5).

ORNAMENTAL TREES SHALL BE A MINIMUM OF 6' HEIGHT AT INSTALLATION (84-334(b)(5). ALL REQUIRED LANDSCAPING SHALL BE IRRIGATED BY AN UNDERGROUND IRRIGATION SYSTEM APPROVED BY THE ADMINISTRATOR (84-334(g).

LANDSCAPE AREAS WHICH ARE ADJACENT TO PAVEMENT SHALL BE PROTECTED WITH CONCRETE CURBS OR EQUIVALENT BARRIERS (84-334(i).

REQUIRED: 25,831SF STREETYARD LESS 10,000SF = 15,831SF/2,000SF = 7.9+10 = 18LARGE TREES

PROVIDED: INCLUDES 10 EXISTING LARGE TREES AND 8 EXISTING SMALL TREES = 14 EXISTING LARGE TREES AND 4 PROPOSED LARGE TREES = 18 LARGE TREES

\*STREET YARD SHRUBS:

REQUIRED: 3,875SF REQD STYD LANDSCAPE LESS 1,500SF = 1,375SF/100SF = 13.75 + 30 = 44

PROVIDED: INCLUDES 45 EXISTING (9 IHC, 5 CL, 8 GSN, 10 DBH, 13 PR) AND 14 PROPOSED (2-RMP, 1-KOR, 11-LPH). SEE PLANT LIST FOR SYMBOL

\*STREET YARD GROUNDCOVER:

REQUIRED: 3,875SF REQD STYD LANDSCAPE LESS 1,500SF = (1,375SF)(0.05) = 68.75SF + 150SF = 219SF

PROVIDED: INCLUDES EXISTING 310SF OF GROUNDCOVER AREA. EXISTING GROUNDCOVER AREAS SHALL BE REPLANTED AS REQUIRED TO PROVIDE A FULL APPEARANCE. SEE GROUNDCOVER BED NOTES, THIS SHEET.

\*\* AT EAST AND WEST PROPERTY LINE WHERE NEW PARKING LOT IS ADJACENT TO PROPERTY LINE, 5' BUFFER AND 6' LIVING SCREEN ARE PROPOSED.

### PLANT LEGEND NOTES:

ALL TREES SHALL BE B & B OR CONTAINER GROWN.

CITY REQUIRED SHRUBS SHALL BE A MINIMUM OF 5 GALLON.

ALL SHRUBS SHALL HAVE A FULL AND UNIFORM HEAD AND BE SIMILAR SHAPE AND SIZE WITHIN SPECIES

MINIMUM TREE CALIPER FOR ALL TREES SHALL BE 3", MEASURED AT 6" ABOVE FINISH GRADE.

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LAN		JENU							
SYM	QTY	COMMON NAME LATIN NAME		SIZE	COMMEN	NTS			
REES									
LO	1	LIVE OAK	QUERCUS VIRGINIANA	3"	SINGLE	STRAIGHT	TRUNK, MIN. 12' HT., 6' SPRD. AT INSTALLATION		
LE	3	LACEBARK ELM	ULMUS PARVIFOLIA	3"	SINGLE	STRAIGHT	TRUNK, MIN. 12' HT., 6' SPRD. AT INSTALLATION		
SHRUBS	6								
ВН	45	BURFORD HOLLY	ILEX CORNUTA 'BURFORDII'			5 GAL	. MIN. 36" HEIGHT AT INSTALLATION, PLANT 4' OC.		
KOR	1	KNOCK OUT ROSE 'RED' ROSA X 'KNOCK OUT' (RED)				5 GAL	. MIN. 24" HEIGHT AT INSTALLATION, PLANT 3' OC.		
LPH	68	HINES PURPLELEAF FRINGE FLOWER LORAPETALUM CHINENSE VAR RUBRUM			RPLE LEAF	5 GAL	. MIN. 36" HEIGHT AT INSTALLATION, PLANT 4' OC.		
RMP	2	MARIE PAVIE ROSE	ROSA X 'MARIE PAVIE'			5 GAL	. MIN. 24" HEIGHT AT INSTALLATION, PLANT 3' OC.		
ROUND	COVER	AND TURF							
AJ	105	ASIAN JASMINE	TRACHELOSPERMUM ASIATICUM		1	GAL.	FULL IN POT, INSTALL 12" ON CENTER		
GL	13	GIANT LIRIOPE	LIRIOPE ?	LIRIOPE ?			FULL IN POT, INSTALL 12" ON CENTER		
LM	7	BIG BLUE LIRIOPE	LIRIOPE MUSCARI 'BIG BLUE'	LIRIOPE MUSCARI 'BIG BLUE'			FULL IN POT, INSTALL 12" ON CENTER		
_PP	23	PURPLE PIXIE FRINGE FLOWER	LORAPETALUM CHINENSE VAR RUBRUM	/ PURPLE PI	XIE' 2	GAL.	FULL IN POT, INSTALL 18" ON CENTER		
NAR	25	NARCISSUS 'GOLDEN DAWN	' NARCISSUS 'GOLDEN DAWN'			BULB	INSTALL 6" ON CENTER		
IDE		SEE CDASS ESTABLISHMENT	T NOTES						

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DATE: 03-17-14

ISSUE: SITE PLAN

**SUBMITTAL** 

REVISION: /<sub>1</sub>\ REV. 03-31-14

SHEET TITLE:

SITE PLAN SUBMITTAL -LANDSCAPE PLAN

# PROJECT DESCRIPTION

SANCTUARY SPACE IN RESPONSE TO THEIR GROWTH. THE NEW ADDITION WOULD HOUSE REGULAR WORSHIP SERVICES. THE OLD SANCTUARY IN THE EXISTING BUILDING WOULD BE DIVIDED INTO CLASSROOMS. THE CHURCH PLANS TO CONTINUE TO USE THE EXISTING FACILITY FOR CLASSROOMS

CURRENTLY SERVICES HELD SUNDAY MORNINGS AT 9:15AM AND 11:00PM. A CHILDREN'S PROGRAM ALSO OFFERED DURING BOTH SERVICES. NORMAL CHURCH OFFICE HOURS ARE MONDAY THROUGH

## LOT INFORMATION

LOCATION: PROPERTY DESCRIPTION:

EULESS, TEXAS 76039, TARRANT COUNTY LOT 1, BLOCK A, GLADE CROSSING BAPTIST CHURCH ADDITION, VOL. 388-201, PG. 38. R-1 RESIDENTIAL

USE INDICATED ON THE 1997 COMP PLAN **GROSS LOT AREA:** 

CURRENT ZONING:

97,539 SQ. FT. - 2.239 ACRES

# VICINITY MAP



# **CONTACT INFORMATION**

LIFE CONNECTION CHURCH OWNER ATTN: PASTOR ROYAL FARRIS

208 NUTMEG LANE EULESS, TX 76039 (817) 788-1414

ARCHITECT GAYLEN HOWARD LAING ARCHITECT, INC.

ATTN: GAYLEN H. LAING, AIA 1300 WEST RANDOL MILL ROAD ARLINGTON, TEXAS 76012 (817) 801-7200

DI SCIULLO-TERRY, STANTON

ENGINEER & ASSOCIATES, INC.

ATTN: JOYCE P. STANTON, P.E., RPLS 401-A WEST ABRAM, BOX 506 ARLINGTON, TEXAS 76004 (817) 275-3361

LANDSCAPE AKM LA

ARCHITECT ATTN: ALIS K. MAHLEN, LANDSCAPE ARCHITECT P.O. BOX 17850

FORT WORTH, TEXAS 76102 (817) 875-1839

STRUCTURAL CALLAHAN STRUCTURAL ENGINEERING **ENGINEER** ATTN: PATRICK, P.E.

817 TUCKER ST

TOTAL SPACES PROVIDED:

FORT WORTH, TEXAS 76104 (817) 335-3909

# PARKING INFORMATION

PARKING GROUP: GROUP 23 REQUIREMENT: REQUIRED NUMBER OF SPACES: **EXISTING NUMBER OF PARKING SPACES:** PROPSED ADDITIONAL NUMBER OF SPACES:

1 PER 4 SEATS

# EMERGENCY ACCESS

WITHIN EMERGENCY ACCESS DRAINAGE AND UTILITY EASEMENTS (E.A.D.U.E.) (aka: fire lanes) THE ROADWAY SURFACE, SUBGRADE, MARKINGS AND SIGNAGE SHALL BE MAINTÁINED AT ALL TIMÉS TO ALLOW FOR THE CLEAR PASSAGE OF EMERGENCY VEHICLES. CLEAR PASSAGE SHALL INCLUDE BOTH HORIZONTAL AND VERTICAL WIDTHS ACCORDING TO CLEARANCES ESTABLISHED IN THE FIRE MARSHAL'S POLICY STATEMENT.

**ARCHITECTURE** INTERIOR

ANNING

DESIGN

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HURCH

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DATE: 03-17-14

ISSUE: SITE PLAN SUBMITTAL

**REVISION:** 

REV. 03-31-14

**SHEET TITLE:** 

**ARCHITECTURAL** SITE PLAN

Specifications

EPA: 2.0 ft<sup>2</sup> (.28 m<sup>2</sup>)

Length: 24-19/32 (62.5)

Width: 17-25/32 (62.5)

Weight: 52 lbs (23.6 kg)


Depth: 8-5/16 (21.1)

Arm: 4 (10.2)

(includes arm)

**Area Lighting** KSF2 400M R4SC

METAL HALIDE: 400W 20' Mounting KSF2 400M R4SC TEST NO: 1193041301P ISOILLUMINANCE PLOT (Footcandle)

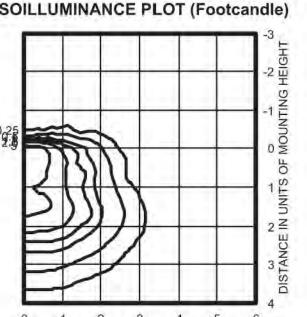

400W pulse start metal halide lamp, rated 38000 lumens. Footcandle values based on 20' mounting height. Classification: Unclassified (Type IV, Very Short), Full Cutoff

POLE MOUNTED LIGHT PHOTOMETRICS

SCALE: NTS


**Cutoff Wall Packs** 



# TWR1C

METAL HALIDE: 70-175W HIGH PRESSURE SODIUM: 70-150W




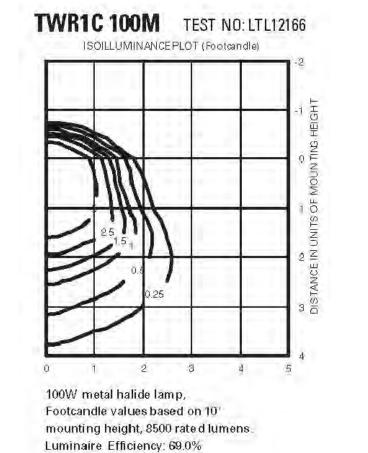


Specifications

Height: 10-1/4 (26.0) Width: 13 (33.0) Depth: 8-1/2 (21.5) \*Weight: 16.45lbs/ 7.46kg 03 WALL MOUNTED LIGHT PHOTOMETRICS


SCALE: NTS

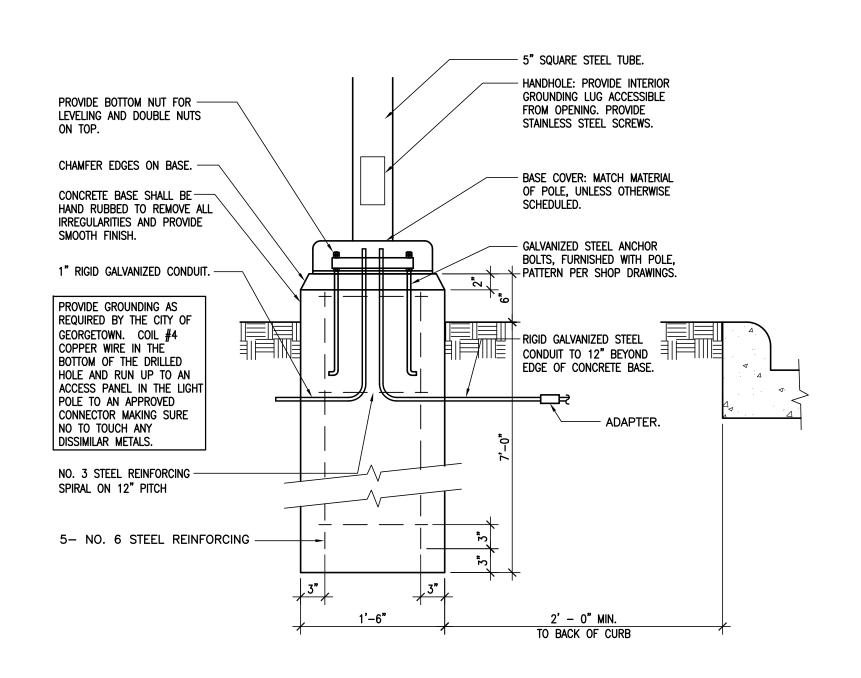

POLE LIGHT BASE SCALE: 1"=1'-0"

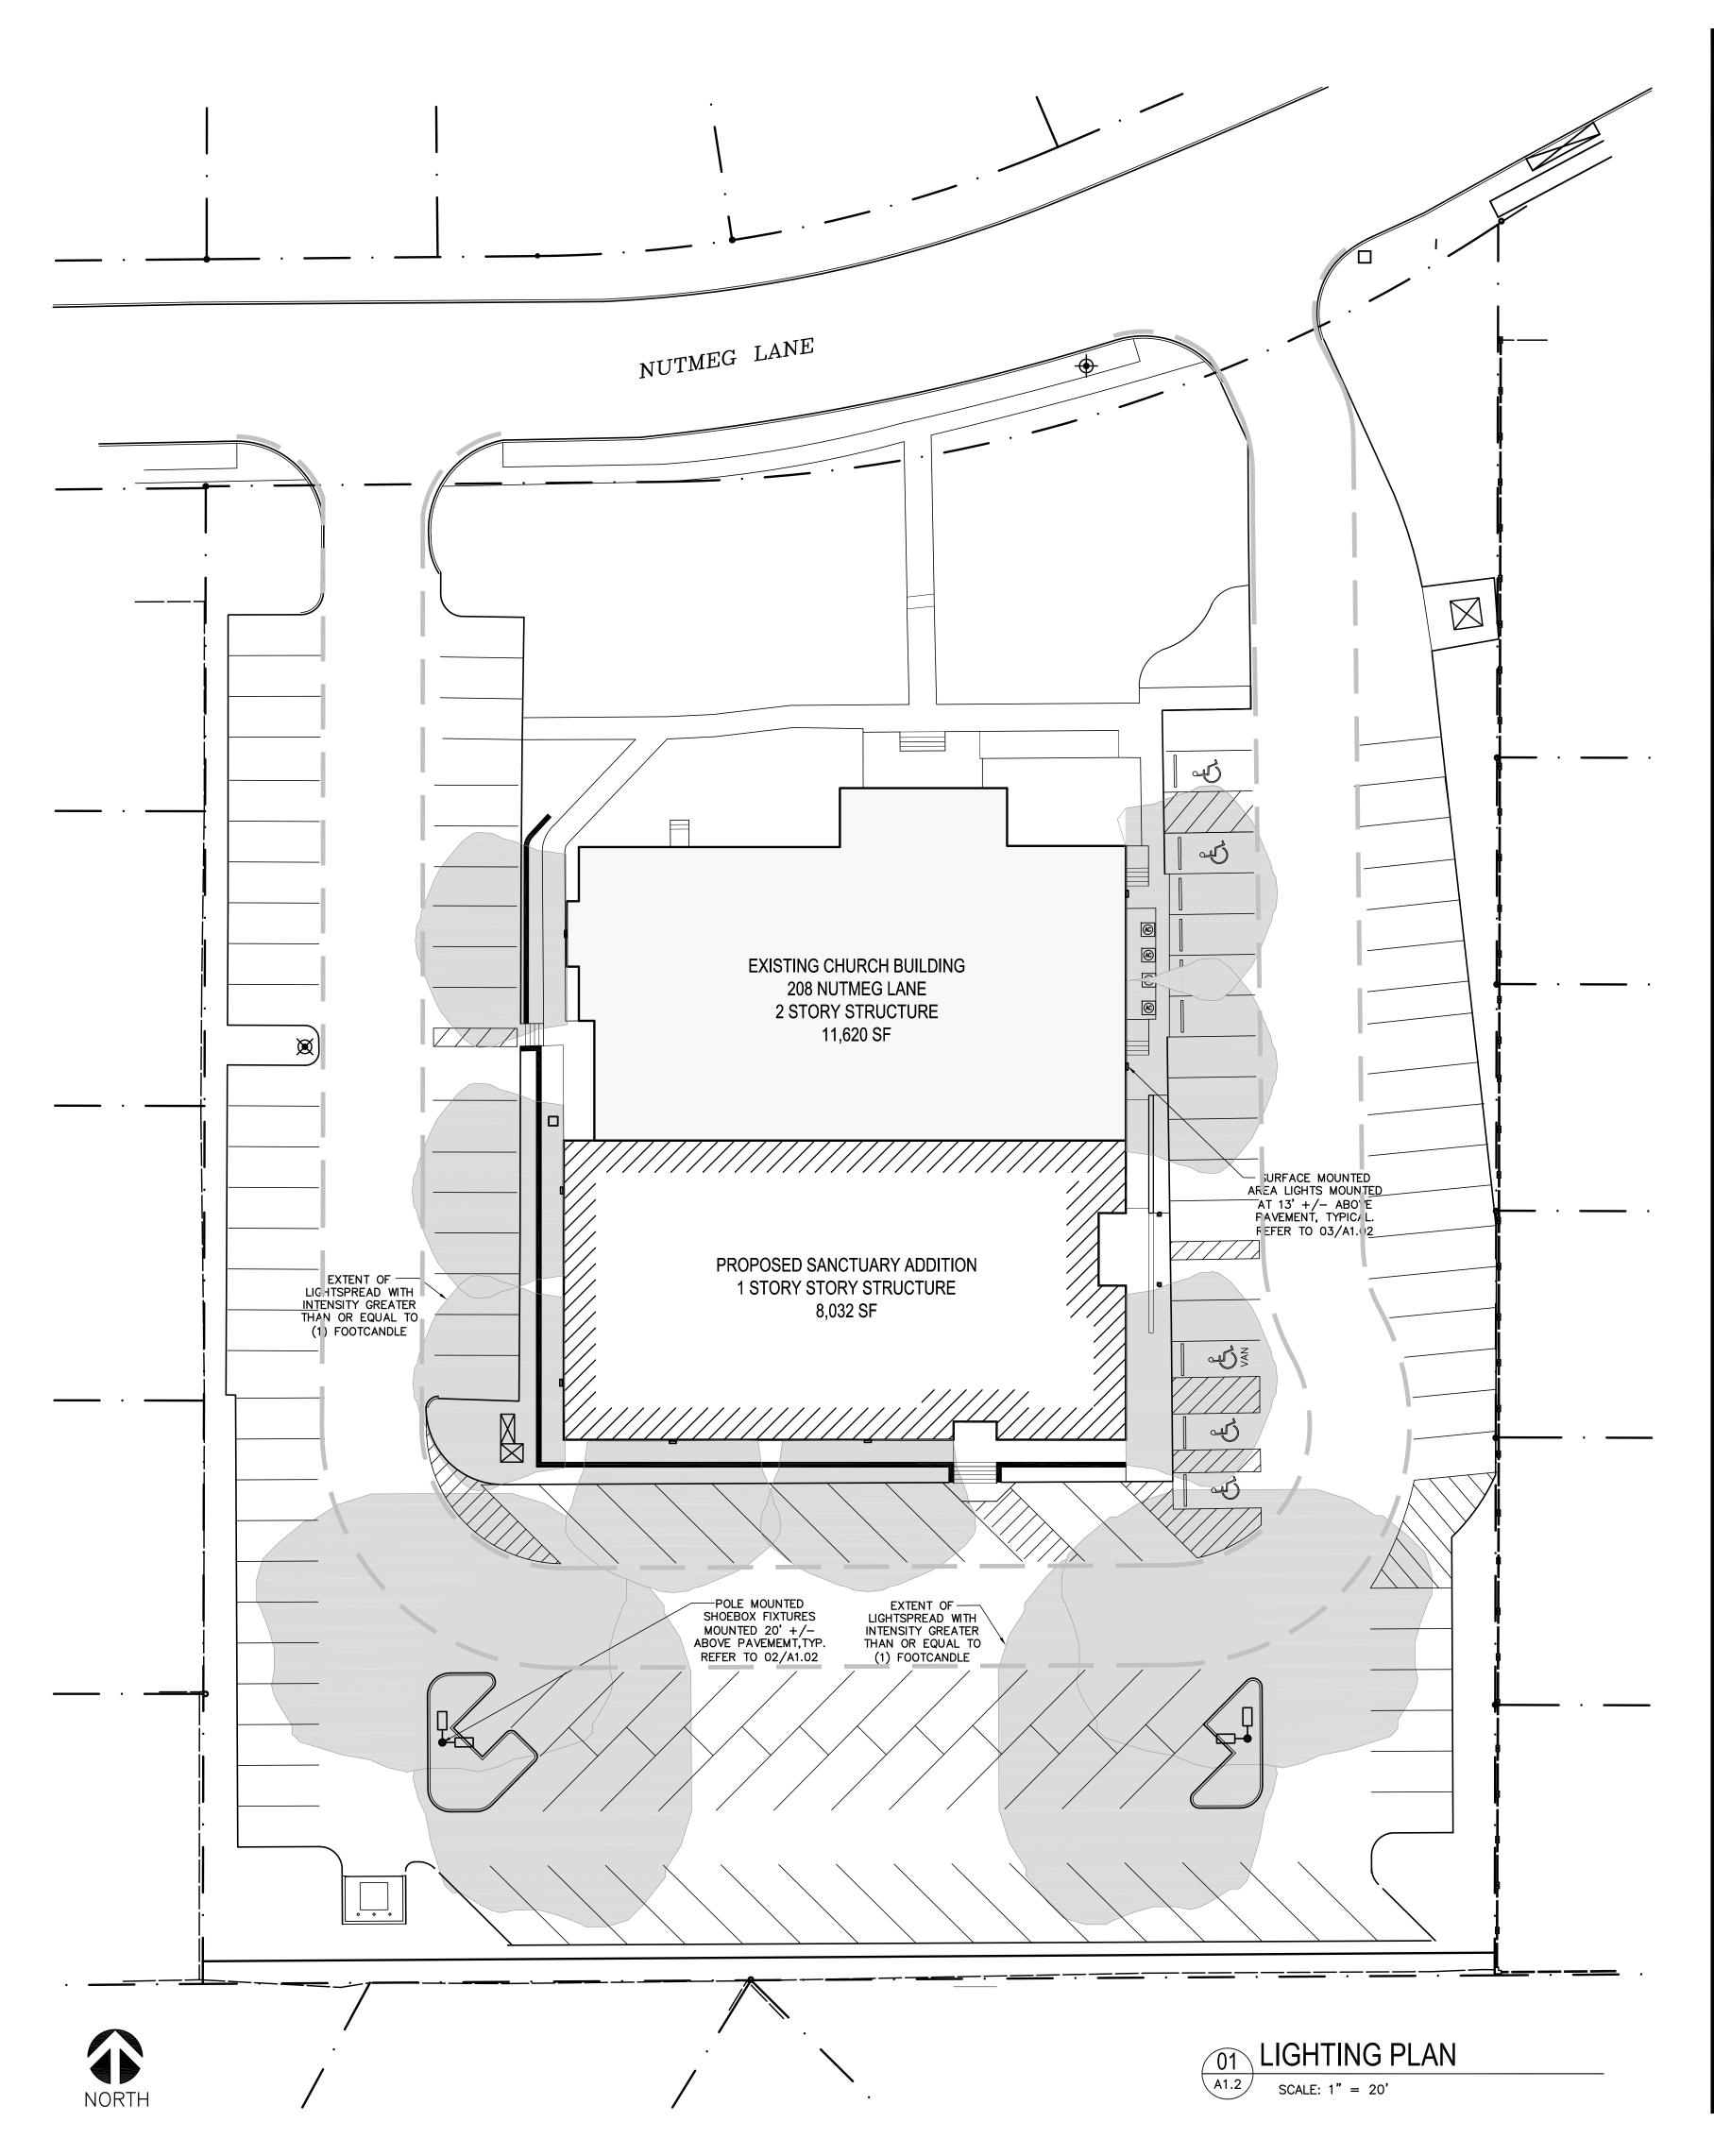

ARCHITECTURE
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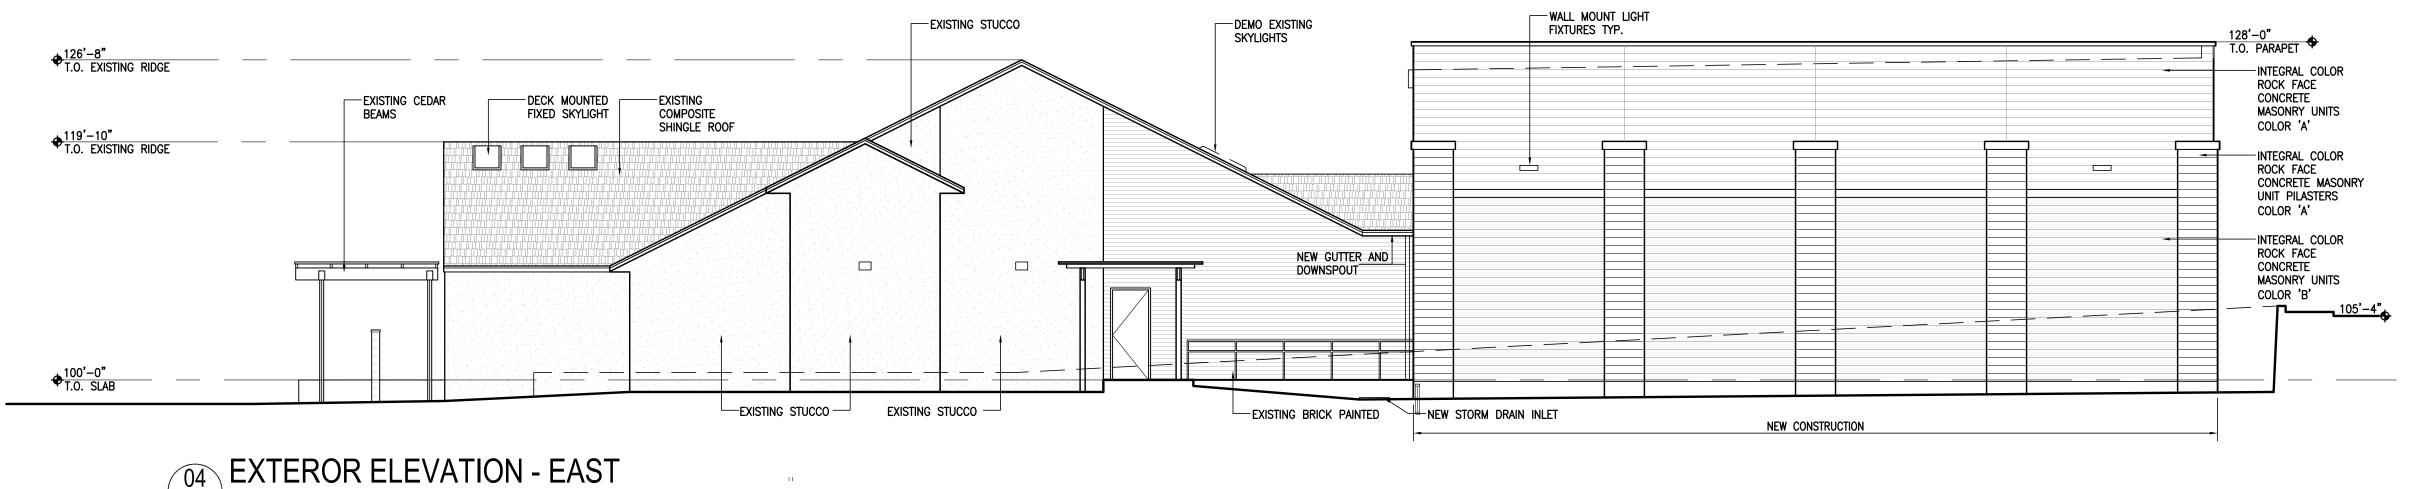
SHEET TITLE:

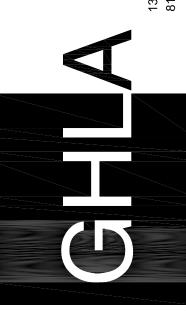LIGHTING PLAN


SUBMITTAL **REVISION:** REV 03-31-14

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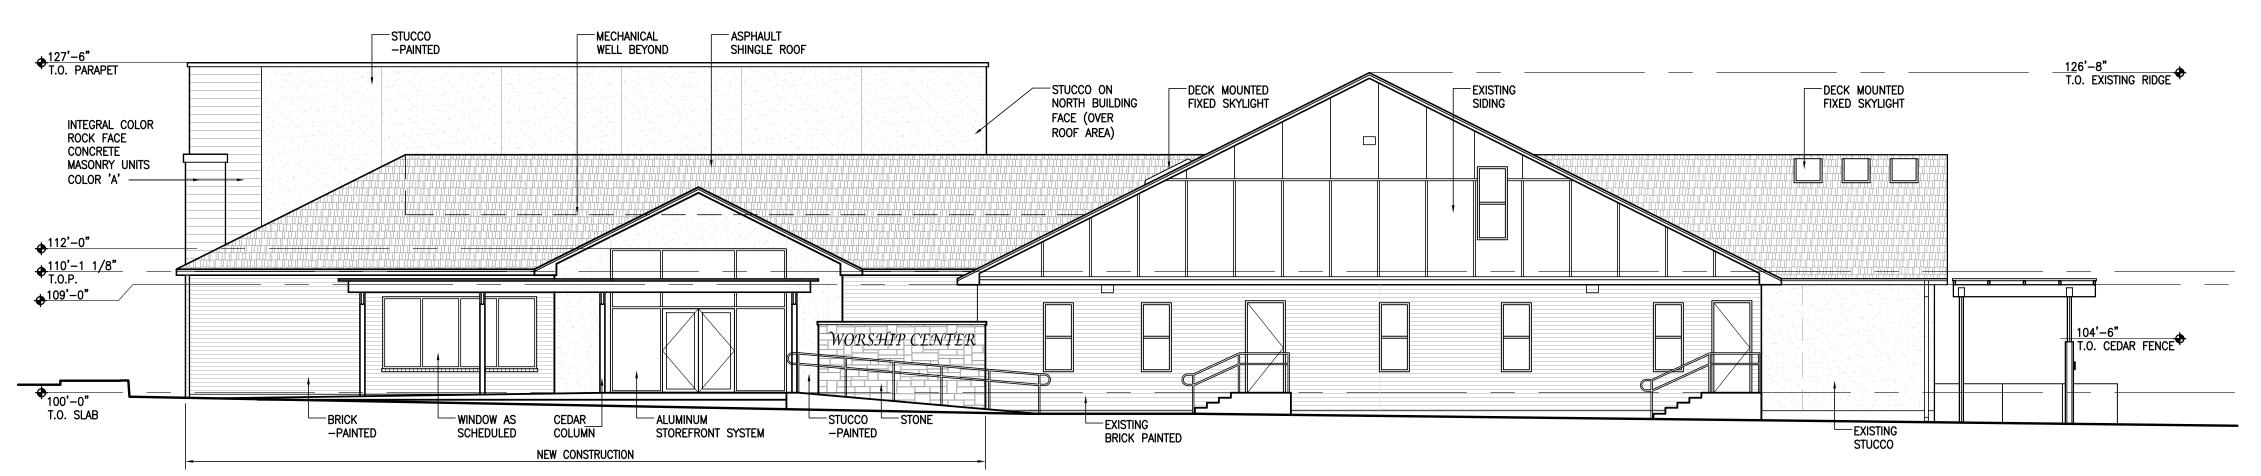
**EXTERIOR ELEVATIONS** 



# SCALE: 1/8" = 1'-0'

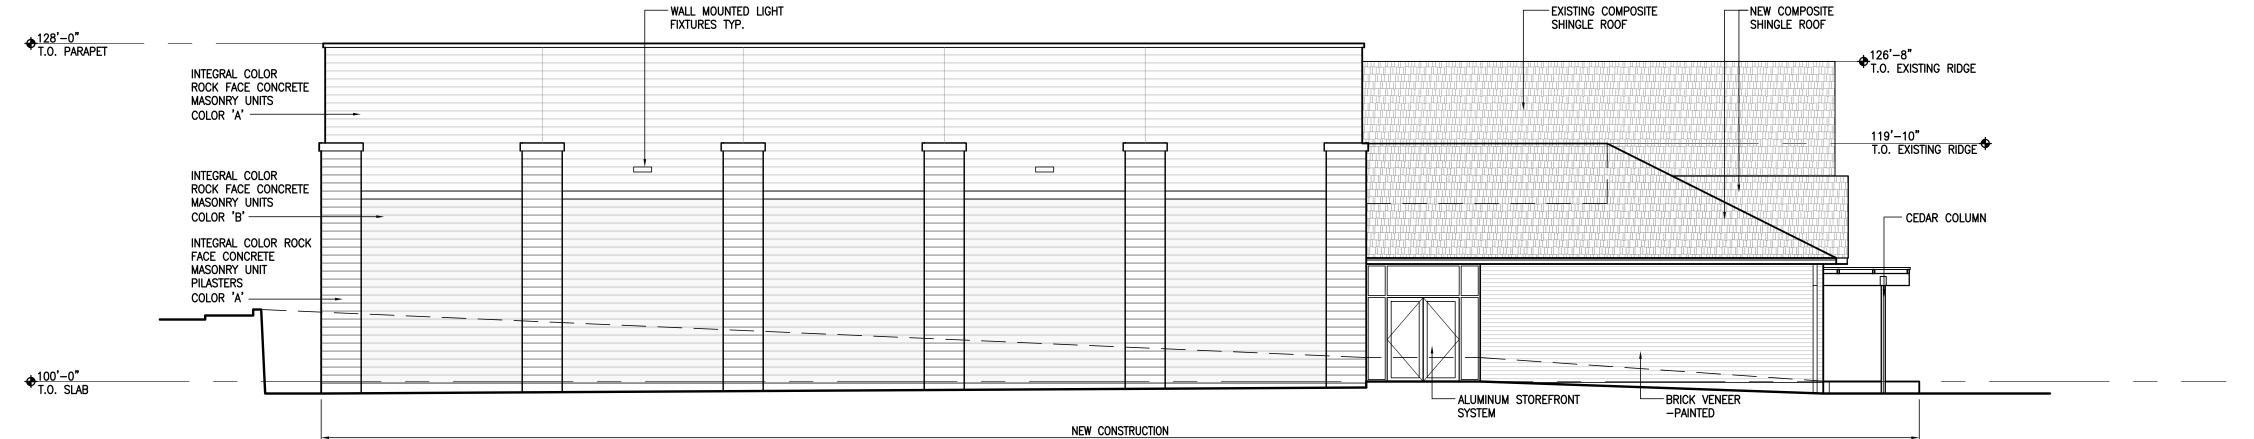

## EXTEROR ELEVATION - SOUTH SCALE: 1/8" = 1'-0'



# O2 EXTEROR ELEVATION - WEST SCALE: 1/8" =1'-0'

